NEW RESIDENCE FOR:

JOHN and BARB HALFMAN

LOT 48, RTE. 14 BENTON, NEW YORK

GENERAL NOTES:

THESE NOTES ARE INTENDED AS A COMPLEMENTARY SUPPLEMENT TO THE THESE NOTES ARE INTENDED AS A COMPLEMENTARY SUPPLEMENT TO THE DRAWINGS. WORK IS TO BE DONE ACCORDING TO THE BEST TRADE STANDARDS TO RESULT IN A COMPLETE JOB. ALL WORK IS TO CONFORM TO THE LATEST EDITION OF THE NEW YORK STATE UNIFORM THIS PREVENTION AND BULLDING CODE AND ALL BUILDING AND ZONING ORDINANCES OF TOWN OF BENTON, NEW YORK. THE GENERAL CONDITIONS OF THE CONTRACT, AIA A201 LATEST EDITION, IS A PART OF THE CONTRACT DOCUMENTS.

1. INSURANCE/BONDS -- TO BE PROVIDED BY THE CONTRACTOR PER THE OWNER'S

2. THE CONTRACTOR SHALL INDEMNIFY THE OWNER AND HIS AGENTS THROUGH ADEQUATE INSURANCE COVERACE AGAINST ANY CLAIMS ARISING FROM INJURIES DURING CONSTRUCTION, EXCAVATION OF DEMOLITION OR FAILURE TO MAINTAIN SAFE CONDITIONS ON THE CONSTRUCTION SITE.

3. CONTRACTOR IS TO COORDINATE ALL TRADES ON THE PROJECT AND TO COORDINATE WITH ANY WORK DONE UNDER SEPARATE CONTRACT WITH THE OWNER BY OTHER FORCES.

4. CONTRACTOR IS TO COORDINATE THE USE OF OR LOCATION OF PORTABLE TOILETS, AND STORED MATERIALS OR EQUIPMENT WITH THE OWNER.

5. ALL TEMPORARY POWER, HEAT, TELEPHONE AND WATER IS TO BE REVIEWED AND

6. CONTRACTOR IS TO APPLY AND PAY FOR ALL REQUIRED PERMITS AND FEES FOR THE WORK AND TO SCHEDULE AND COORDINATE ALL REQUIRED INSPECTIONS, INCLUDING OBTAINING A CERTIFICATE OF OCCUPANCY.

7. CONTRACTOR TO BE RESPONSIBLE FOR CONSTRUCTION MEANS, METHODS, TECHNIQUES, SEQUENCE OR PROCEDURES, AND SAFETY PRECAUTIONS AND PROGRAMS IN CONNECTION WITH THE WORK.

8. CONTRACTOR IS TO VERIFY ALL NOTES AND DIMENSIONS PRIOR TO ORDERING, CONSTRUCTION AND/OR INSTALLATION OF ANY PREFABRICATED COMPONENTS AND BE RESPONSIBLE FOR ERRORS AND OMISSIONS.

9. CONTRACTOR TO BE RESPONSIBLE FOR MATERIALS AND WORKMANSHIP. SUBSTITUTIONS FOR MATERIALS SPECIFIED, TO BE MADE WITH PERMISSION OF THE LOCAL BUILDING DEPARTMENT AND DOCUMENTED.

10. CONTRACTOR TO ENSURE THAT THE PRE-FAB FIREPLACE CONSTRUCTION MEETS OR EXCEEDS ALL APPLICABLE CODES, PROVIDE COMBUSTION AIR VENTS WITH SCREEN AND BACK DAMPER FOR ANY APPLIANCE WITH AN OPEN FLAME. PROVIDE HORIZONTAL DRAFT STOPS PER CODE AT EACH FLOOR.

11. THESE PLANS HAVE BEEN PREPARED ACCORDING TO NEW YORK STATE BUILDING CODE REQUIREMENTS. CONTRACTOR WILL BE RESPONSIBLE TO ADAPT THESE PLANS TO SUIT THE NEEDS OF THE BUILDING SITE, AS REQUIRED, AS LO AS SUCH ADAPTIONS DO NOT VIOLATE THE BUILDING OR LOCAL CODE AND DO NOT ALTER THE STRUCTURAL INTEGRITY OF THE STRUCTURE.

12. CONTRACTOR TO BE RESPONSIBLE FOR COMPLIANCE WITH ALL APPLICABLE STATE & LOCAL BUILDING, ELECTRICAL, MECHANICAL, SANITARY AND ENERGY

13. CONTRACTOR TO BE RESPONSIBLE TO THE LOCAL BUILDING DEPARTMENT AND THEIR INTERPRETATION OF THE CODE SHOULD IT DIFFER FROM THESE PLANS.

14. CONTRACTOR TO BE RESPONSIBLE THAT ALL WINDOWS AND DOORS INSTALLED MEET NEW YORK STATE EGRESS REQUIREMENTS (OPENING SIZE AND HARDWARE.)

15. PLUMBING, MECHANICAL, AND ELECTRICAL SUBCONTRACTORS T RESPONSIBLE FOR ADHERING TO ALL APPLICABLE CODES AND SAFE

16. ALL FOOTINGS TO REST ON UNDISTURBED (ORIGINAL) SOIL. ASSUMED SOIL BEARING CAPACITY TO BE 2000 psi. CONTRACTOR TO NOTIFY DESIGNER OF ANY UNFORSEEN SOIL CONDITIONS AT THE TIME OF DIG.

19. DEMOLITION- PROVIDE TEMPORARY SHORING AND PROTECTION TO PREVENT DAMAGE TO EXISTING STRUCTURE, FINISHES OR LIFE. CUTTING OF UTILITIES SHALL BE REVIEWED AND APPROVED BY OWNER.

TYPICALLY 2x4 (3 ½"). UNLESS OTHERWISE NOTED.

21. DESIGN LOADS ARE:

DESIGN LOADS ARE:
FIRST FLOOR:
SECOND FLOOR:
90 / SQ.FT.
DECKS:
80 / SQ.FT.
DECKS:
80 / SQ.FT.
DESIGN DEAD LOADS:
10 / SQ.FT.

22. WOOD TRUSSES, IF USED, ARE TO BE DESIGNED BY OTHERS, USE 50# (SNOW) 22. WOOD TRUSSES, IF USED, ARE TO BE DESIGNED BY OTHERS, USE 50# (
LIVE LOAD AND CALCULATE ALL OTHER LOADS IMPOSED ON TRUSSES AS
REQUIRED. STRUCTURAL AND INSTALLATION BRACING CONNECTORS TO BE
DESIGNED BY SUPPLIER.

23. FOR ALL DIMENSIONAL LUMBER USE HEM-FIR #2 OR BETTER (JOISTS, BEAMS, HEADERS) UNLESS OTHERWISE NOTED. ALL LUMBER TO BE TRUE & STRAIGHT W/ OUT CRACKS OR SPLITS.

24. ALL LVL MATERIAL TO HAVE A MIN."E' = 1.9 OR BETTER. UTILLIZE

4.3. ALL AREAS OF HABITABLE SPACE WILL BE PROVIDED WITH OPENINGS FOR EMERGENCY EGRESS OF 5.0 SQ.FT. AND HAVE THE PROPER HARDWARE FOR EMERGENCY EGRESS. NET CLEAR OPENING OF 18" WIDTH MINIMUM. EGRESS WINDOWS TO HAVE A MAXIMUM FINISHED SILL HEIGHT OF 44" FROM FINISHED FLOOR.

27. GLAZING WITHIN 18" OF FINISHED FLOOR OR GRADE, 24" OF A DOOR, OR LOCATED 60" OF THE FLOOR AT BATHTUBS, WHIRLPOOLS, SHOWERS, SAUNAS, STEAM ROOMS, OR HUT TUBS TO BE TEMPERED OR SAFETY GLASS.

28. ALL ELECTRICAL WORK IS TO BE INSPECTED BY AN APPROVED INSPECTION AUTHORITY AND BY THE LOCAL ELECTRICAL UTILITY COMPANY.

29. PROVIDE A 110V SMOKE DETECTOR AT EACH FLOOR, INCLUDING BASEMENT, IN EACH BEDROOM AND 29. PROVIDE A 110V SMOKE DETECTOR AT EACH FLOOR, INCLUDING BASEMENT, IN EACH BEDROOM AND JUST OUTSIDE EACH BEDROOM AS PER NYS CODE SECTION R317. ALL SMOKE DETECTORS TO BE INTERCONNECTED, HARDWIRED ON A SINGLE LINE THAT IS PERMANENT AND WITHOUT A DISCONNECT SWITCH OTHER THAN AS REQUIRED FOR OVER CURRENT PROTECTION. ALARMS SHALL BE INTERCONNECTED IN SUCH MANNER THAT ACTIVATION OF ONE ALARM ACTIVATES ALL OF THE ALARMS WITHIN THE RESIDENCE. AT LEAST ONE CARBON MONOXIDE (CO) DETECTOR MUST ALSO BE PROVIDED WITHIN THE DWELLING AND MUST BE HARDWIRED WITH THE SMOKE DETECTOR LIPE PER NYS CODE SECTION 1225.2. THE COD DETECTOR MUST ALSO CONTRACTED TO A WHOLE HOUSE SECURITY SYSTEM.

31. ALL INTERIOR WALLS TO RECEIVE 1/2" GYPSUM BOARD, UNLESS NOTED OTHERWISE.

32. ALL BATHROOM AND TOILET AREA WALLS AND CEILINGS ADJACENT TO WET AREAS TO RECEIVE WATER RESISTANT GYPSUM BOARD.

33. WALLS COMMON TO GARAGE AND HOUSE, AND CEILING OF GARAGE TO RECEIVE $5/8^\circ$ TYPE'X', 1 HOUR FIRE RATED GYPSUM BOARD, ON BOTH SIDES OF WALL AS PER CODE.

34. BATHROOMS, POWDER ROOMS, LAUNDRY AND UTILITY ROOMS TO BE VENTED TO THE OUTSIDE WITH A MINIMUM OF A 90 CFM FAN.

35. EXTERIOR FLASHING TO BE CORRECTLY INSTALLED AT ALL CONNECTIONS BETWEEN ROOFS, WALLS, CHIBNEYS, PROJECTIONS, AND PENETRATIONS AS REQUIRED BY APPROVED CONSTRUCTION PRACTICES AND LOCAL CODE.

36. ATTIC, ROOF AND SOFFIT VENTS TO MEET OR EXCEED LOCAL CODE REQUIREMENTS

37. ALL PLUMBING AND MECHANICAL VENTS ARE TO BE LOCATED CLOSE TOGETHER WITHIN THE ATTIC WHENEVER POSSIBLE TO MINIMIZE THE NUMBER OF ROOF PENETRATIONS. ALL VENTS APPEARING ABOVE THE ROOF TO BE LOCATED AWAY FROM PROMINENT VIEW. ALL METAL AND PVC VENTS AND PENETRATIONS TO BE PRIMED AND PAINTED TO CLOSELY MATCH THE ROOF COLOR.

38. IF INSTALLED, GUTTERS AND DOWNSPOUTS ARE TO PROVIDE A POSITIVE DRAINAGE OF 1/4" PERFOOT MINIMUM AND ARE TO CONNECT TO DOWNSPOUTS WITH 4" EXTENSIONS. DOWNSPOUT EXTENSION OF BE PLACED AS NOT CREATE A PREDESTRIAN ON VEHICLE ITEMFECH ADARD, OR "BLACK ICE" THAT MAY CAUSE AN INJURY. IF LOCAL JURISDICTION ALLOWS CONNECTION TO THE STORM SEWER, PROVIDE A PLAN FOR APPROVAL BY THE LOCAL BUILDING DEPARTMENT.

39. ELECTRIC AND GAS METERS TO BE LOCATED AWAY FROM PROMINENT VIEW BUT IN AN ACCESSIBLE LOCATION FOR SERVICE AND MONITORING BY LOCAL UTILITIES.

40. ELECTRIC PANEL BOX TO BE 200AMP SERVICE MOUNTED ON PLYWOOD IN ACCORDANCE WITH LOCAL

41. ELECTRICAL AND LIGHTING LAYOUT ILLUSTRATE BASIC DESIGN INTENT. ELECTRICAL CONTRACTOR TO BE RESPONSIBLE FOR ADHERING TO ALL APPLICABLE CODES, AND CROSS COORDINATION WITH OWNER FOR FIXTURE LOCATIONS.

43. PROVIDE WATERPROOF GFI OUTLETS FOR ALL EXTERIOR OUTLETS.

 ${\tt 45.}\,$ ALL HOSE BIBS TO BE FREEZE-PROOF, REFERENCE FOUNDATION AND FIRST FLOOR PLANS FOR LOCATIONS.

46. THESE DRAWINGS HAVE BEEN PREPARED FOR STRUCTURAL REFERENCE ONLY. MECHANICAL AND OTHER BUILDING SYSTEMS, IF REQUIRED, ARE TO BE DONE BY OTHERS.

47. ALL PIPING INSTALLATION TO BE INSTALLED PER CURRENT RESIDENTIAL CODE OF NEW YORK STATE, GENERAL PLUMBING REQUIREMENTS CODE CHAPTER 26.

48. REFER TO ATTATCHED RES-CHECK REPORT DATED 8/20/07

FRAMING NOTES:

FRAMER WILL VERIEY ALL NOTES AND DIMENSIONS CONCERNING ALL WOOF FRAMING AND ANY RELATED WORK TO BE PERFORMED IN THIS CONTRACT PRIOR TO STARTING THE WORK.

2. FRAMER WILL VERIFY OVERLAP OF CRITICAL DIMENSIONS WITH THE MASON / FOUNDATION CONTRACTOR.

3. FRAMER WILL VERIFY ALL ROUGH OPENINGS FOR FINISHED ITEMS (WINDOWS, DOORS, ETC.) TO BE INSTALLED IN WOOD FRAMED WALLS, FLOORS, CEILINGS AND ROOFS WITH MANUFACTURERS' DATA. DATA TO BE SUPPLIED BY G.C., MATERIALS'

4. ROUGH FRAMED OPENINGS FOR STAIRS SHALL MEET (AT MINIMUM) OR EXCEED ANY APPLICABLE CODE REQUIREMENTS FOR FINISHED HEADROOM CLEARANCE ABOVE STAIR TREADS AND WIDTH (MEASURED BETWEEN HANDRAILS).

5. EXTERIOR WALLS TO BE FRAMED IN 2x6 WOOD STUDS @ 16" O.C. (MAX.), UNLESS OTHERWISE NOTED

INTERIOR WALLS ARE TO BE FRAMED IN 2x4 WOOD STUDS @ 16" O.C. (MAX.) UNLESS OTHERWISE NOTED. REFERENCE WALL TYPE KEY.

7. USE PRESSURE TREATED LUMBER WHEREVER IN DIRECT CONTACT WITH MASONRY, CONCRETE OR WITHIN 6" OF GRADE.

8. PRESSURE TREATED LUMBER IS TO BE USED TO CONSTRUCT ANY EXTERIOR STAIR, RAILING, DECK SYSTEM UNLESS OTHERWISE NOTED.

9. ALL WALL AND FLOOR SYSTEMS ARE TO BE FIRE-STOPPED PER APPLLICABLE

11. PROVIDE SUITABLE CHASES IN WALLS AND FLOOR SYSTEMS TO ACCOMMODATE PLUMBING AND HEATING INSTALLATIONS. DO NOT VERTICALLY CHISEL THROUGH ANY LVL'S OR TRIPLE STRUCTURAL MEMBERS. CONSULT LVL MANUFACTURERS' GUIDELINES FOR ALLOWABLE HOLE SIZE AND LOCATIONS. CONSULT DESIGNER FOR GUIDELINES FUR ALLOWABLE HOLE SIZE AND LOCATIONS. CONSULT DESIGNER FOR ALTERNATE SOLUTIONS AT DIFFICULT LOCATIONS. METAL STRAPPING IS TO BE USED TO TIE TOGETHER ANY SILL OR TOP PLATES COMPROMISED BY PLUMBING OR DUCT INSTALLATION.

13. ALL STRUCTURAL STEEL TO CONFORM WITH ASTM SPECIFICATION A-36.

14. PROVIDE "X" BRACING OR SOLID BLOCKING AT A MAXIMUM OF 6° - 0° O.C. AT ALL FLOOR JOISTS. IF A HYDRONIC RADIANT HEATING SYSTEM IS BEING INSTALLED, ALLOW SPACE ABOVE SOLID BLOCKING FOR THE INSTALLATION OF TUBING. DO NOT COMPRESS TUBING.

15. FLOOR CONSTRUCTION TO BE $\frac{3}{4}$ " TOUNGUE AND GROOVE SUBFLOOR. FINISH MATERIAL TO BE APPLIED OVER SUBFLOOR. GLUE AND SCREW PLYWOOD DECKING TO FLOOR JOIST TO ENSURE A "NONSQUEAK" FLOOR SYSTEM.

16. UNLESS OTHERWISE NOTED, PROVIDE DOUBLE HEADER JOISTS AND TRIMMERS AT ALL FLOOR OPENINGS, NOTED, PROVIDE DEBOTE HEADERS WITH \(\frac{1}{2} \)" PLYWOOD GLUED AND NAILED BETWEEN FOR ALL OPENINGS IN 2x6 WALLS. AND DOUBLE 2x12 HEADERS NAILED TOGETHER FOR AL OPENINGS IN 2x4 WALLS.

17. EXTERIOR WALLS TO BE SHEATHED WITH MIN. 1/2" EXTERIOR GRADE PLYWOOD

18. PROVIDE INSULATION BAFFLES AT EAVE VENTS BETWEEN RAFTERS / TRUSSES.

19. PROVIDE FULL SOLID BEARING OR STUD BEARING UNDER ALL BEAM BEARING


GENERAL SITE NOTES:

1. GENERAL CONTRACTOR TO VERIPY THE EXISTING TOPOGRAPHIC GRADE LEVELS, LOCATION OF TREES AND THE PROPOSED HOUSE LOCATION. GENERAL CONTRACTOR TO COMMUNICATE TO OWNER AND DESIGNER ANY RECOMMENDED CHANGES BEFORE THE START OF ANY WORK.

. GENERAL CONTRACTOR TO HAVE A LISCENSED ENGINEER OR SURVEYOR TAKE-OUT OR VERIFY THE HOUSE LOCATION TO ENSURE THAT THE HOUSE DOES STAKE-OUT OR VERIFY THE HOUSE LOCATION TO ENSURE THAT THE HOUSE DOES NOT ENCROACH ON ANY SETBACKS OR EASEMENTS, UNLESS A VARIANCE HAS BEEN GRANTED FROM THE LOCAL ZONING BOARD. GENERAL CONTRACTOR TO COMMUNICATE TO THE OWNER AND DESIGNER ANY ENCROACHMENT ISSUES.

3. GENERAL CONTRACTOR TO LOCATE ALL UTILITY SERVICES (1.E. WATER, ELECTRIC, SEWER, GAS, PHONE) AND COORDINATE THE EXTENSIONSTO THE HOUSE WITH THE APPROPRIATE INSTALLER. ALL CONNECTIONS, METERS, CLEAN-OUTS, ETC. TO BE LOCATED AWAY FROM ANY PROMINENT VIEW.

4. GENERAL CONTRACTOR TO COORDINATE FINISH TOPOGRAPHIC GRADING AND PAVING (WALKS, DRIVEWAYS, PATIOS, ETC.) AS REQUIRED TO PROMOTE POSITIVE DRAINAGE AWAY FROM THE HOUSE.

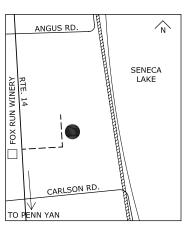

LOCATION MAP

PROJECT # 0640

in • site: architecture



GENEVA VOICE: 585 237 2614 FAX: 585 237 3679 2 BORDEN AVE. SUITE 202 PERRY, NY 14610 www.insitearch.com


SHEET INDEX


TITLE PAGE	GENERAL NOTES, ABBREVIATIONS, LOCATION MAP
S-1.0	STRUCTURAL PLANS AND DETAILS
A-1.0	FOUNDATION/SITE PLANS
A-2.0	FIRST FLOOR PLAN/FIREPLACE DETAIL
A-3.0	SECOND FLOOR/ROOF PLANS/KITCHEN ELEV.
A-4.0	N/S EXTERIOR ELEVATIONS
A-5.0	W/E BUILDING SECTIONS
A-6.0	BUILDING SECTIONS
A-7.0	BUILDING SECTIONS
A-8.0	NOT USED
A-9.0	INTERIOR ELEVATIONS
A-10.0	SCHEDULES
A-11.0	DETAILS
A-12.0	DETAILS
E-1.0	REFLECTED CEILING /ELECTRICAL PLANS


BUILDING DATA
BASEMENT = 520 SQ. FT.
FIRST FLOOR = 1757 SQ. FT.
SECOND FLOOR TOTAL = 553 SQ. FT. SECOND FLOOR HABITABLE = 295 SQ. FT.


GARAGE = 864 SQ. FT. SCREEN PORCH = 141 SQ. FT.


AUGUST 20, 2007

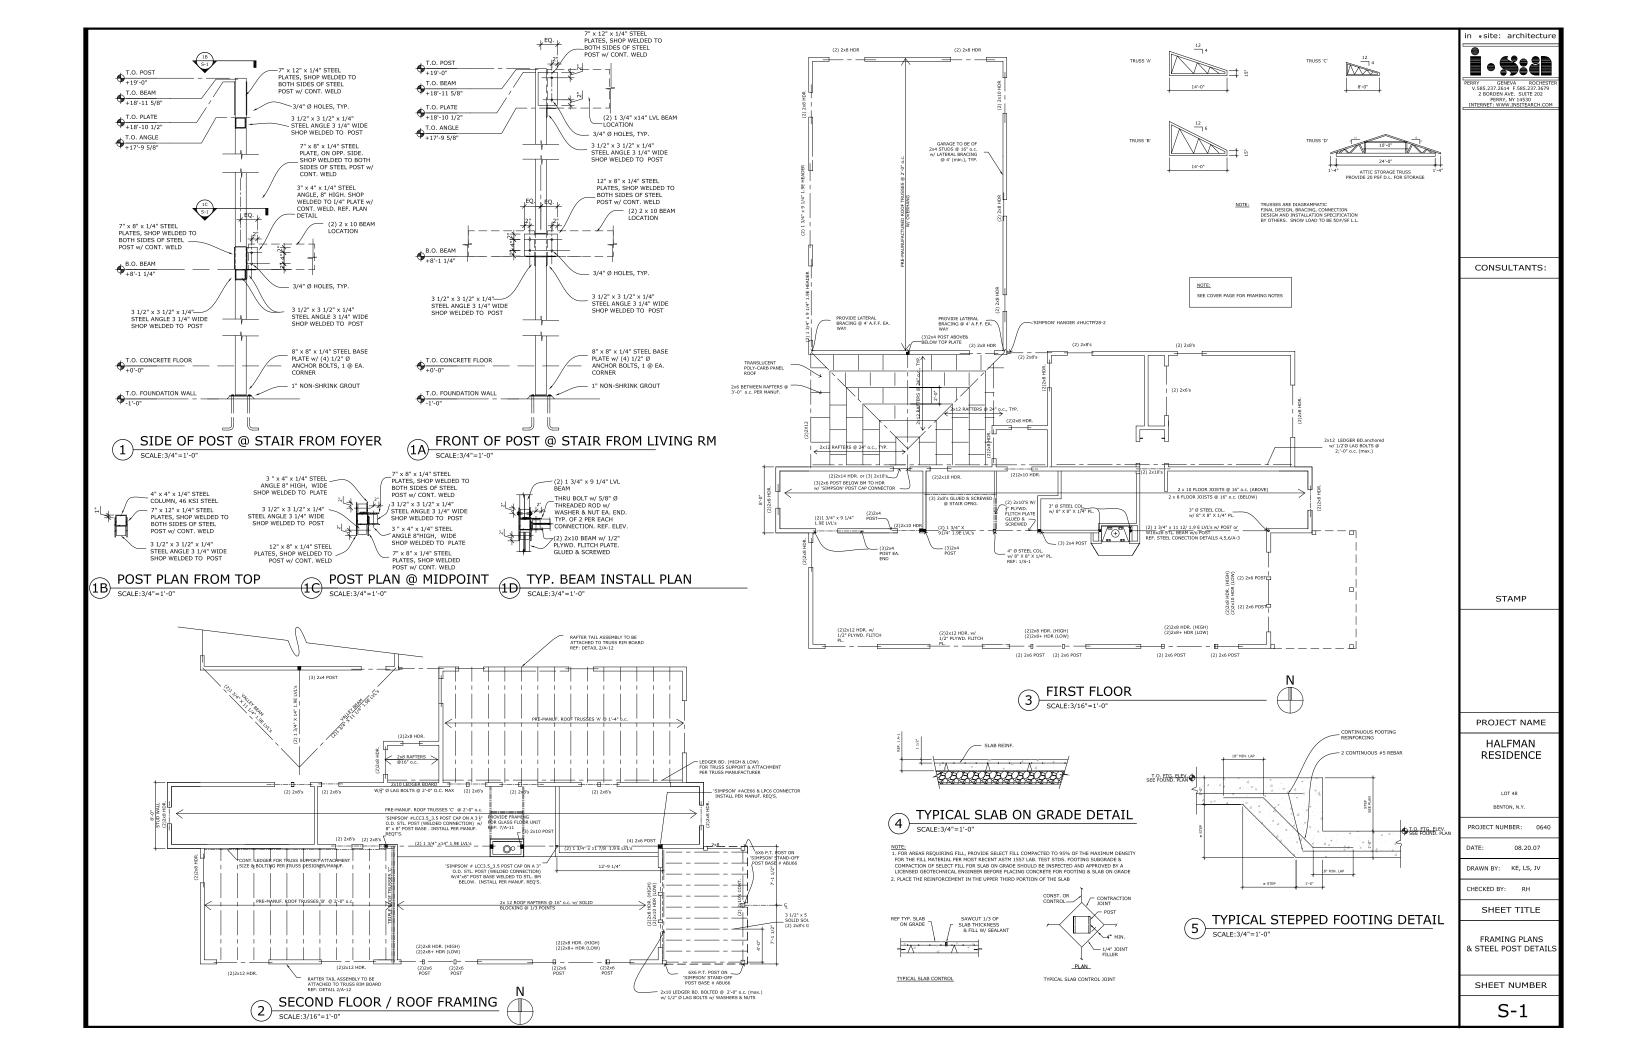


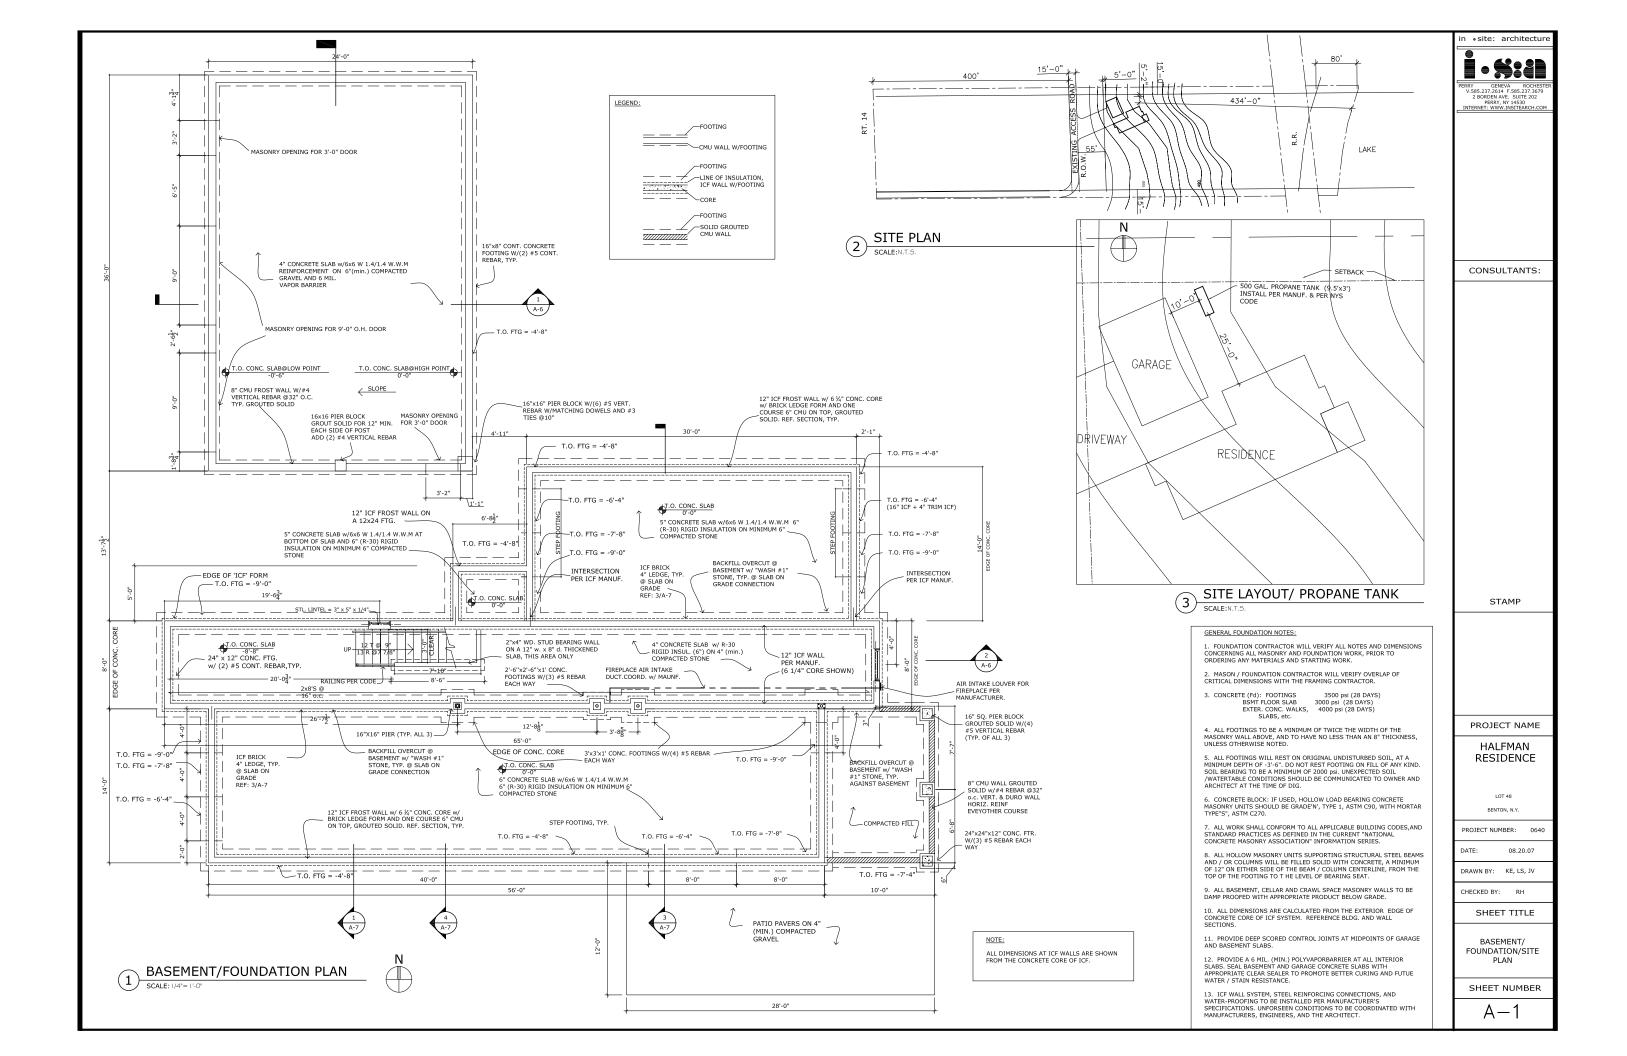


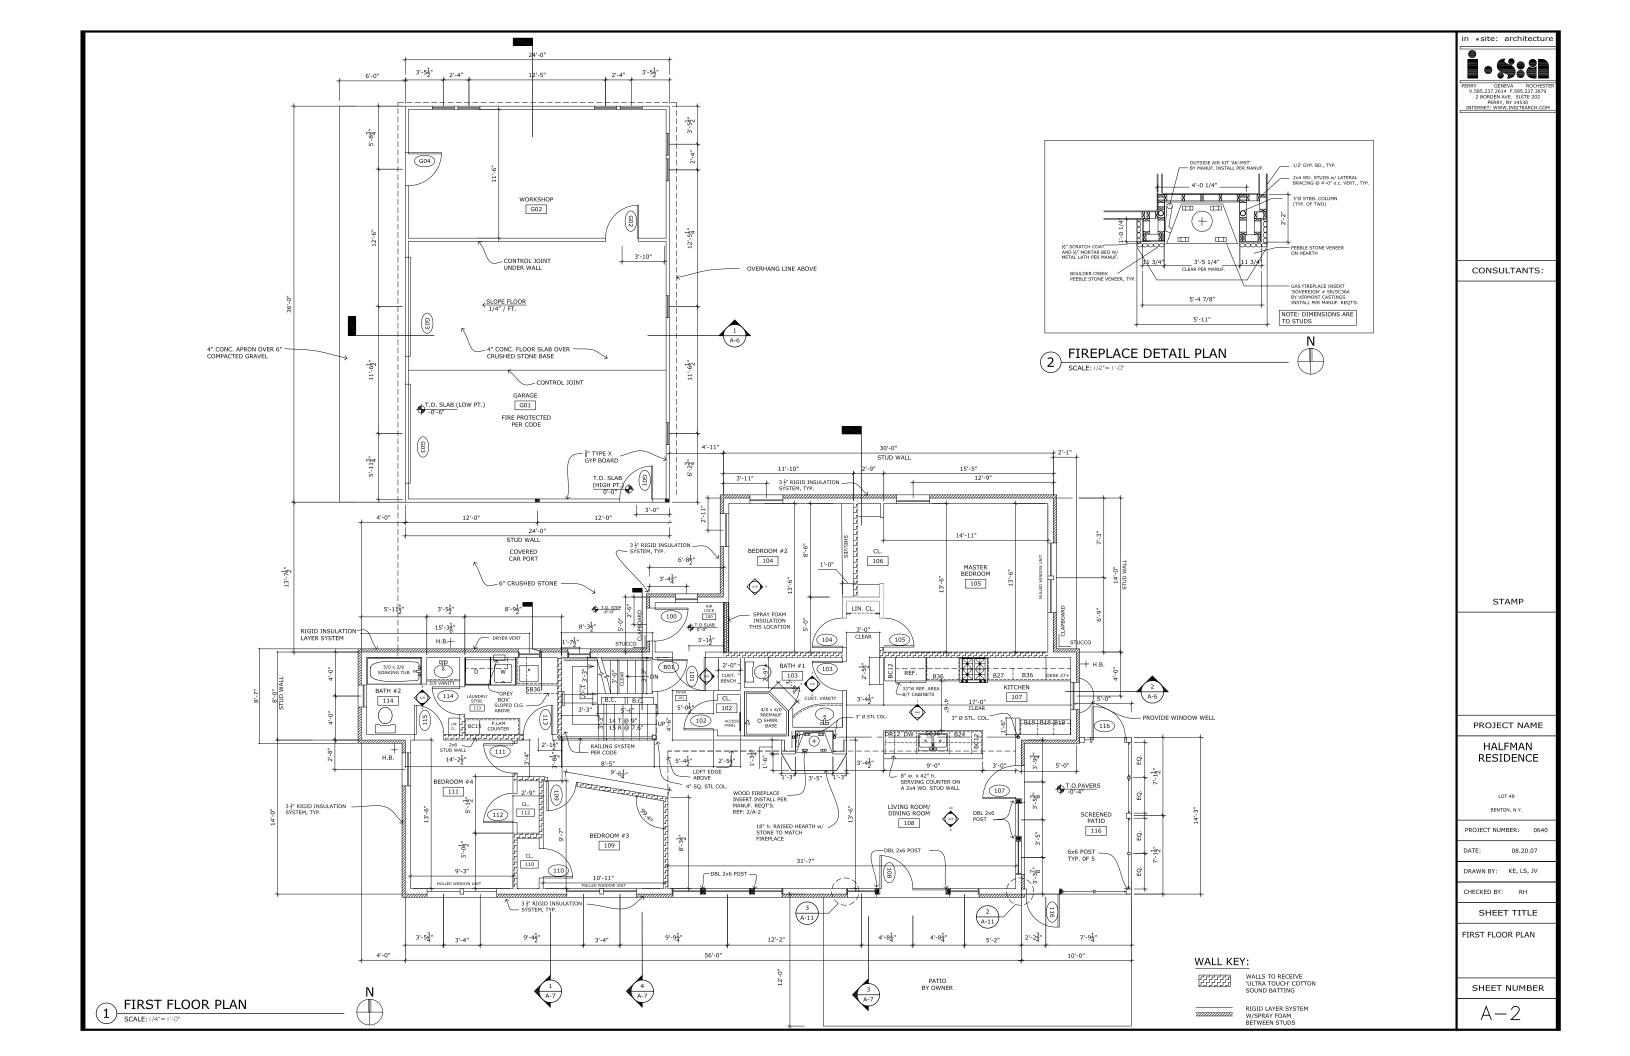

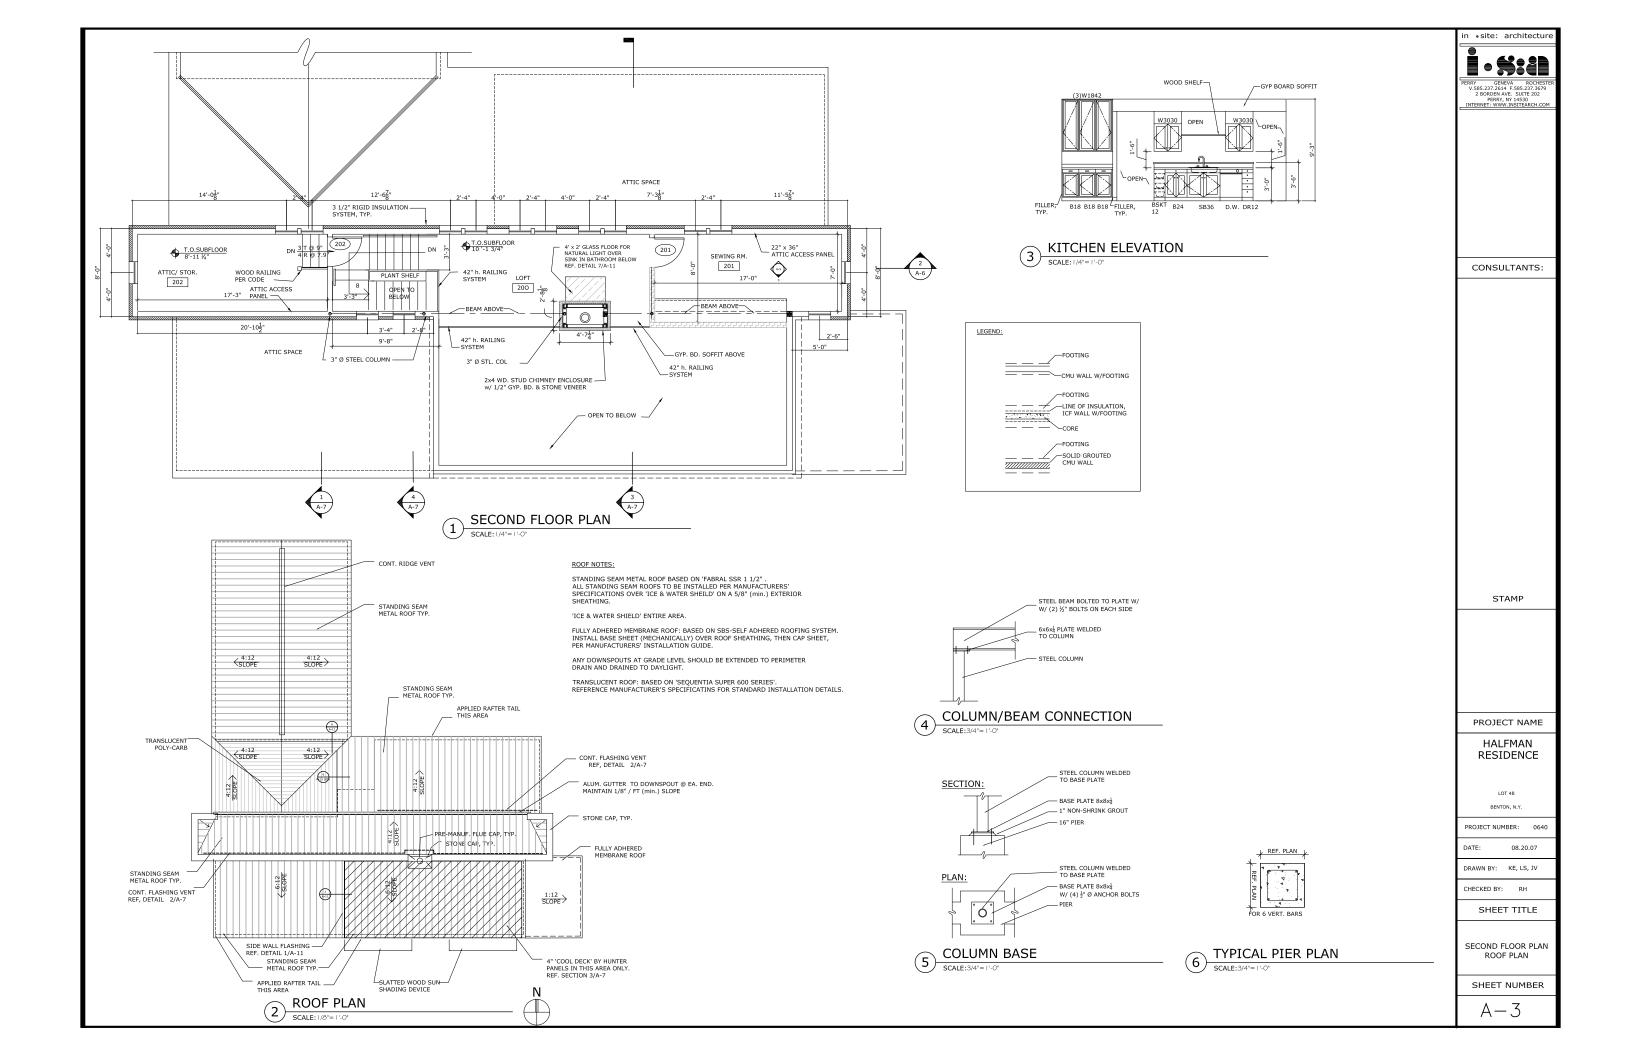

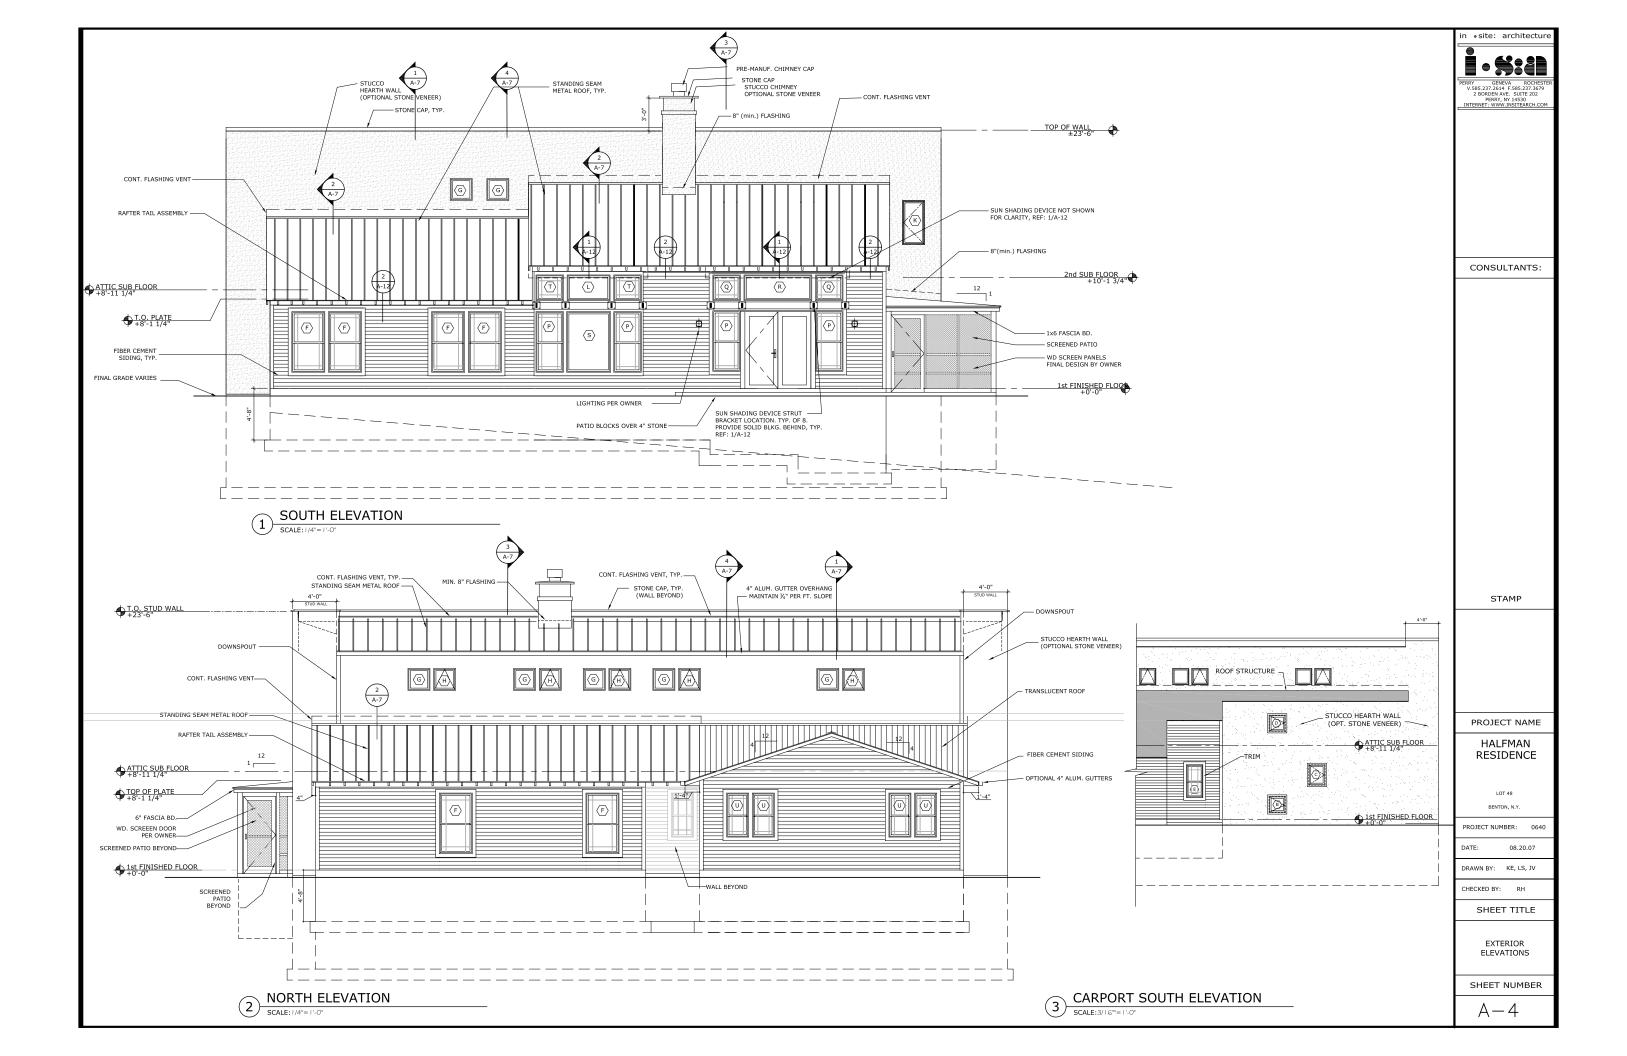


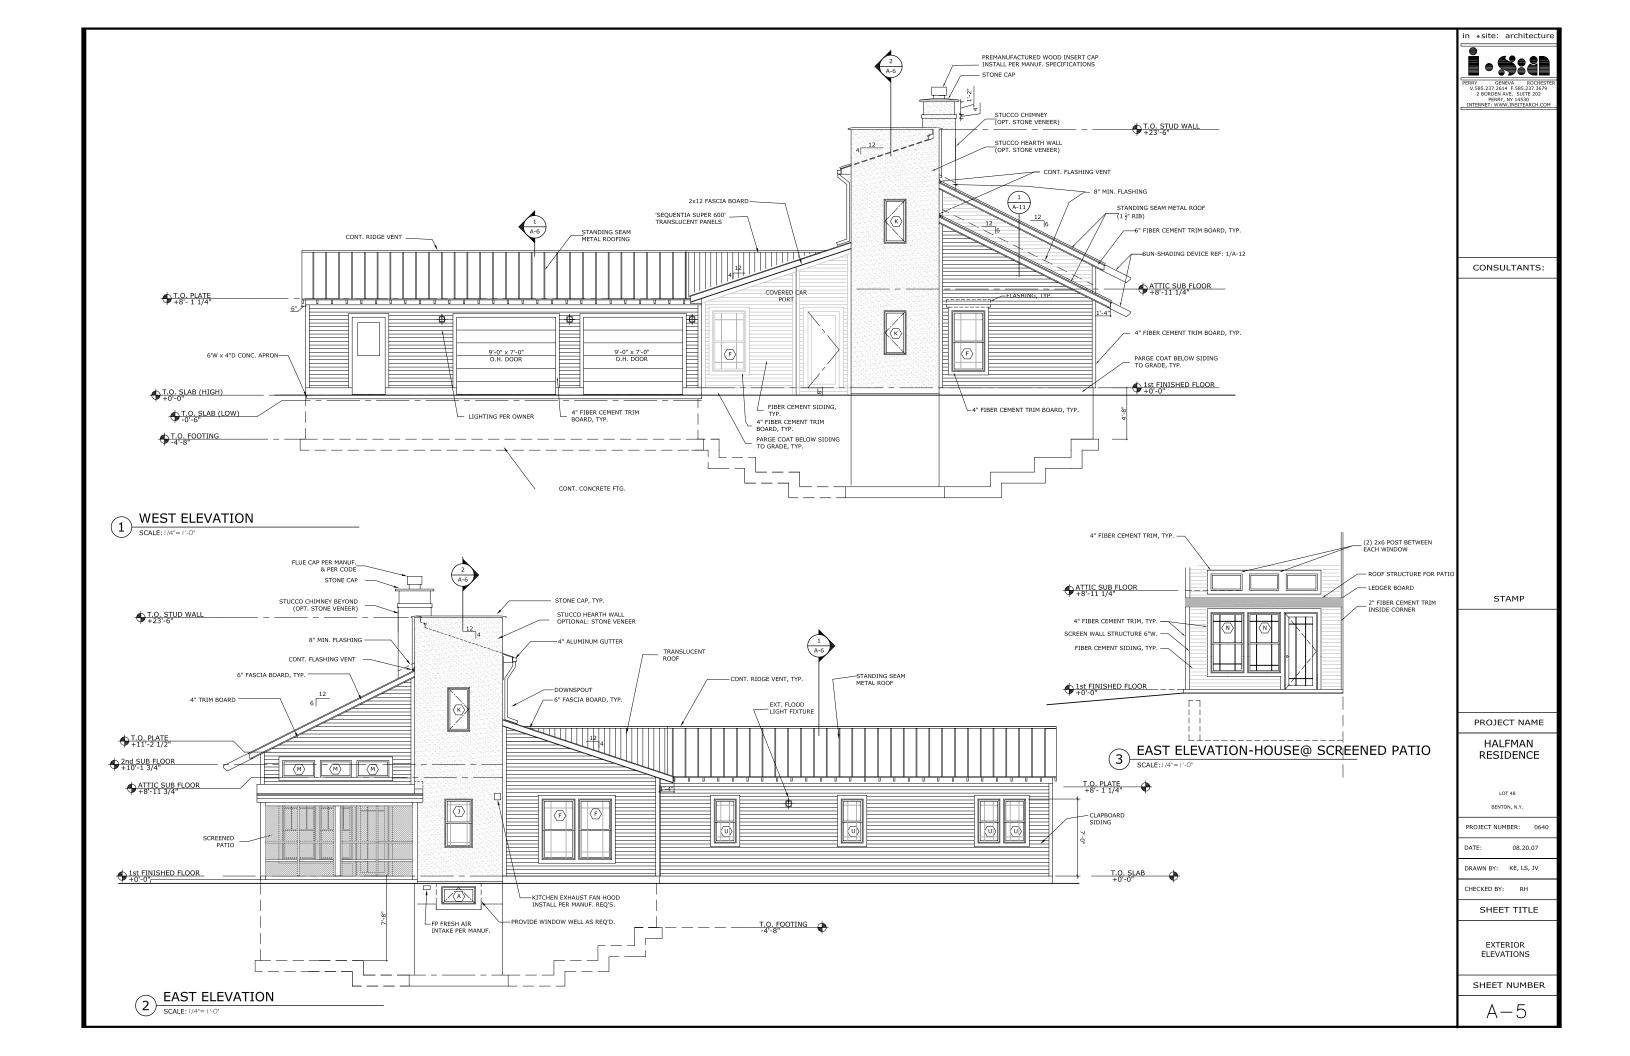

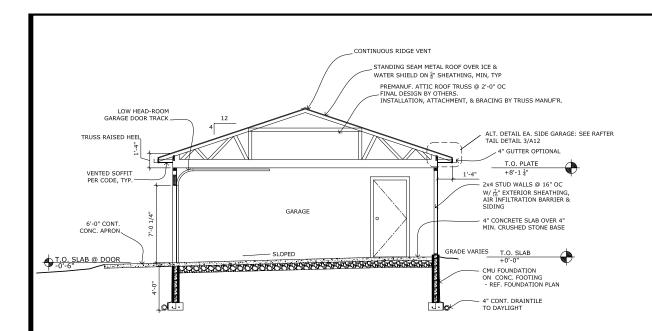

SECTION THRU GARAGE

SCALE:1/4"=1'-0"

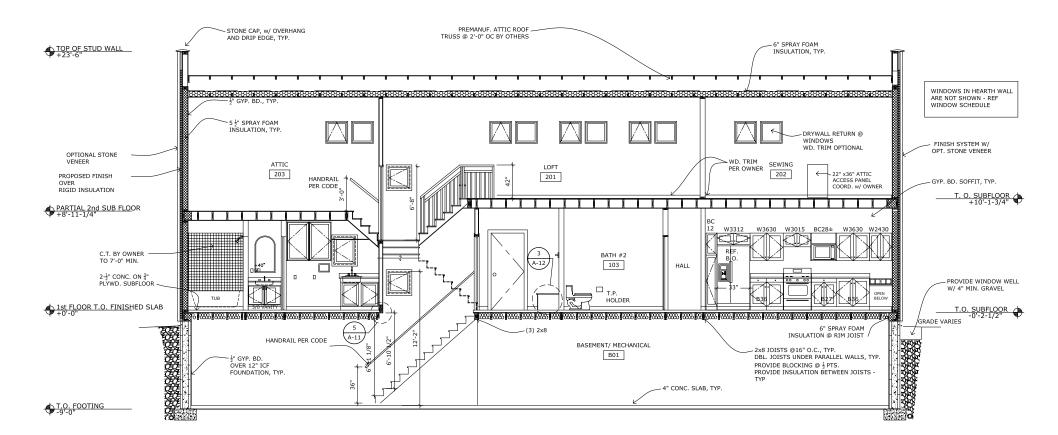

SECTION THRU HEARTH WALL

n •site: architectur

CONSULTANTS:

STAMP

PROJECT NAME

HALFMAN RESIDENCE

> LOT 48 BENTON, N.Y.

PROJECT NUMBER: 0640

DATE: 08.20.07

DRAWN BY: KE, LS, JV


CHECKED BY: RH


SHEET TITLE

SECTIONS

SHEET NUMBER

A-6

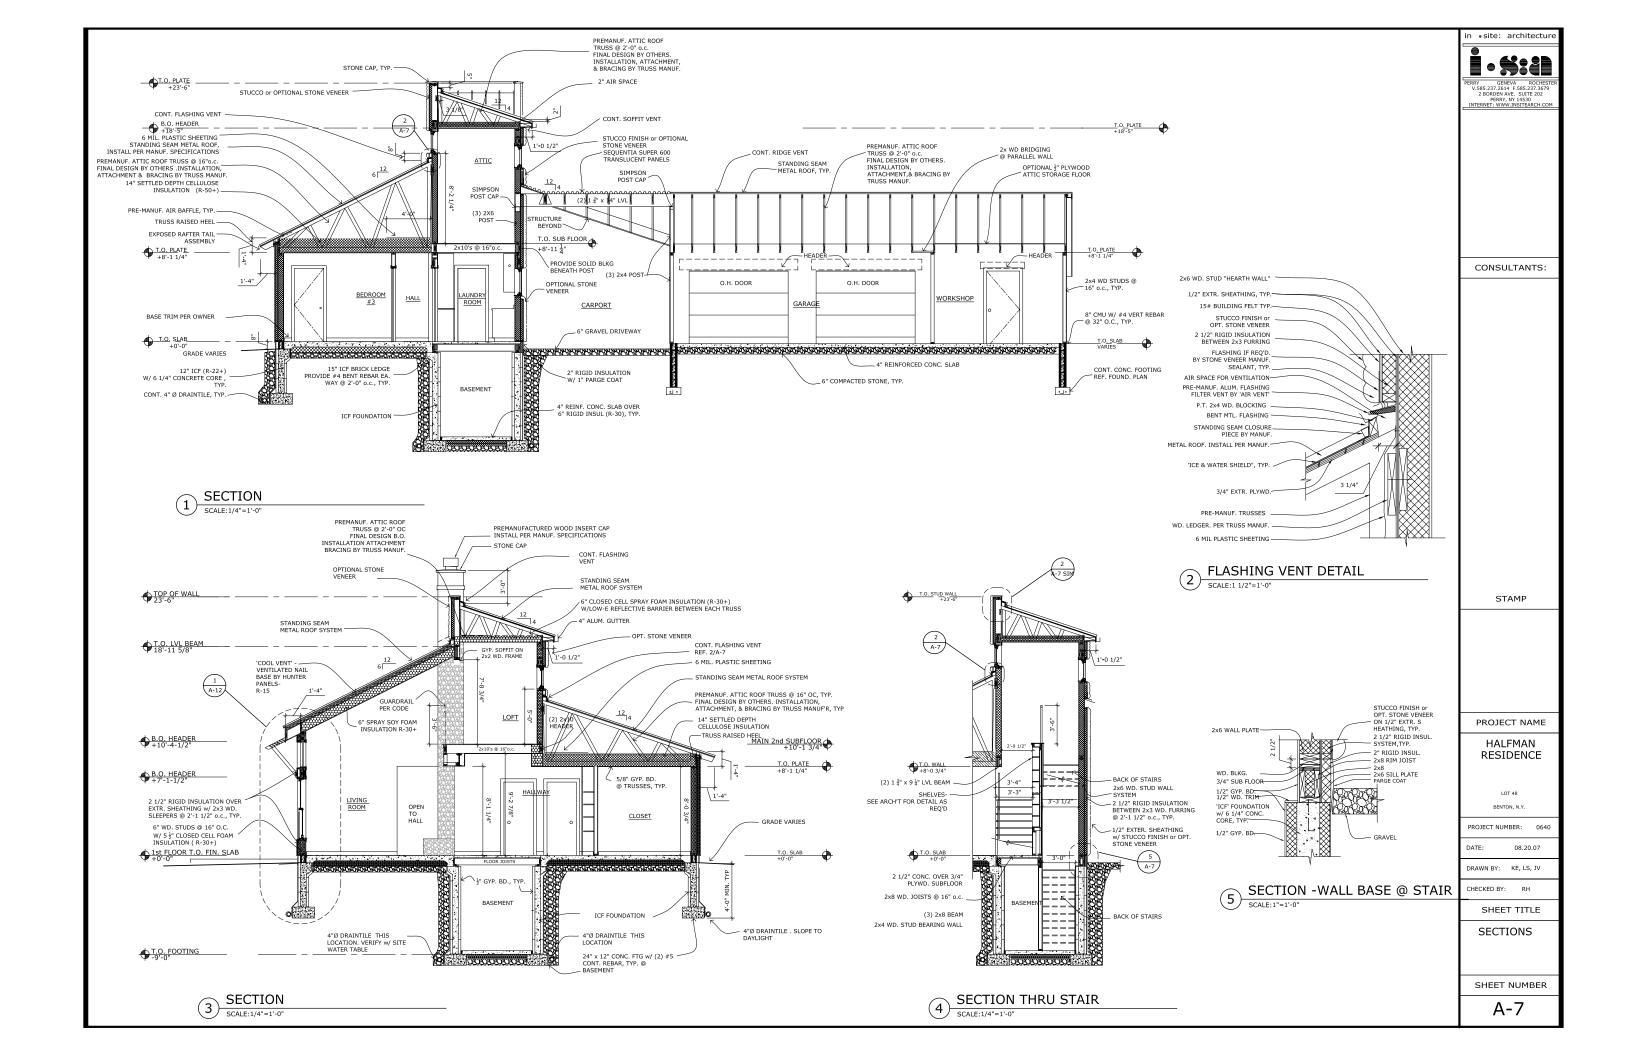

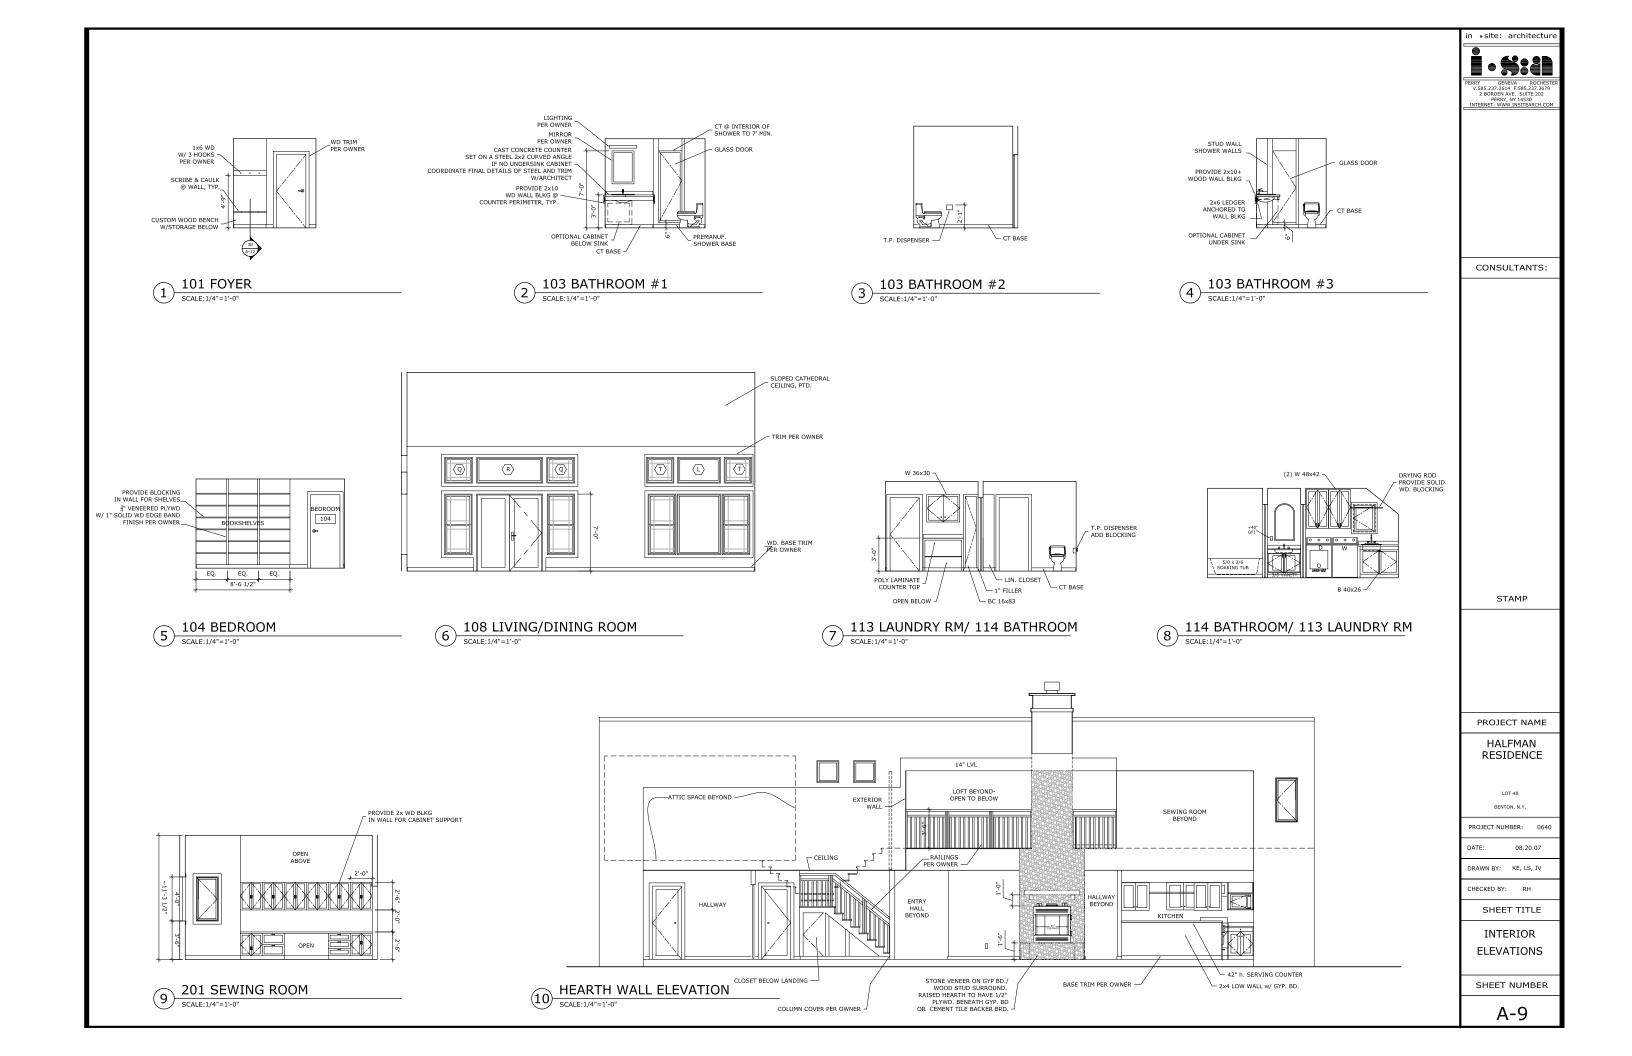

ROOM FINISH SCHEDULE

			FLOOR							WAL	LS			CEILING					
DOOR	ROOM	SUB FLOOR	FINISH	COLOR	BASE MAT'L	COLOR	HT.	MAT'L	. HEIGHT	FIN N	IISH / CC	LOR S	w	MAT'L	FINISH	MLDG.	HEIGHT	NOTES	
G01	GARAGE	CONC.	CONC	SEALED				GWB-2	8'-0"	PT-	PT-	PT-	PT-	GWB	PT-		8'-0"	4' TYPE X EACH WAY@SE CORNER	
G02	WORKSHOP	CONC.	CONC					GWB	8'-0"	PT-	PT-	PT-	PT-	GWB	PT-		8'-0"		
100	AIR LOCK	CONC.	CONC	ST-	WD	PT-	4"	GWB	8'-0"	PT-	PT-	PT-	PT-	GWB	PT-		8'-0"		
101	FOYER	CONC	CONC	ST-	WD	PT-	4"	GWB	8'-0"	PT-	PT-	PT-	PT-	GWB	PT-		8'-0"		
102	CLOSET	CONC	CONC	ST-	WD	PT-	4"	GWB	8'-0"	PT-	PT-	PT-	PT-	GWB	PT-		8'-0"		
103	BATHROOM #1	CONC	СТ	CT-	СТ	CT-	4"	GWB-2	9'-3"	PT-	PT-	PT-	PT-	GWB	PT-		9'-3"	GLASS FLOOR ABOVE	
104	BEDROOM #2	CONC	CPT	CPT-	WD	PT-	4"	GWB	8'-0"	PT-	PT-	PT-	PT-	GWB	PT-		8'-0"		
105	MASTER BEDROOM	CONC	CPT	CPT-	WD	PT-	4"	GWB	8'-0"	PT-	PT-	PT-	PT-	GWB	PT-		8'-0"		
106	CLOSET	CONC	CPT	CPT-	WD	PT-	4"	GWB	8'-0"	ST-	ST-	ST-	ST-	GWB	ST-		8'-0"		
107	KITCHEN	CONC	CK	CK-	WD	PT-	4"	GWB	9'-3"	PT-	PT-	PT-	PT-	GWB	PT-		9'-3"	S WALL KNEE WALL - MEASURE	
108	LIVING/DINING	CONC.	CONC	ST-	WD	PT-	4"	GWB	11'-3 ¾"/ 17'11 ½"	PT-	PT-	PT-	PT-	GWB	PT-		VARIES	N DINING KNEE WALL/N LIVING STONE FIREPL, SURROUND	
109	BEDROOM #3	CONC	CONC	ST-	WD	PT-	4"	GWB	8'-0"	PT-	PT-	PT-	PT-	GWB	PT-		8'-0"		
110	CLOSET	CONC	CONC	ST-	WD	PT-	4"	GWB	8'-0"	PT-	PT-	PT-	PT-	GWB - 2	PT-		8'-0"		
111	BEDROOM #4	CONC	CONC	ST-	WD	PT-	4"	GWB	8'-0"	PT-	PT-	PT-	PT-	GWB - 2	PT-		8'-0"		
112	CLOSET	CONC	CONC	ST-	WD	PT-	4"	GWB	8'-0"	PT-	PT-	PT-	PT-	GWB - 2	PT-		8'-0"		
113	LAUNDRY	CONC	СТ	CT-	WD	PT-	4"	GWB-2	8"-1 ½"/ 7'-8"	PT-	PT-	PT-	PT-	GWB - 2	PT-		VARIES		
114	BATHROOM #2	CONC	СТ	CT-	СТ	СТ-	4"	GWB-2	8'-0"	PT-	PT-	PT-	PT-	GWB	PT-		8'-0"		
116	SCREENED PATIO	STONE							7'-8"	PT-	PT-	PT-	PT-	GWB	PT-		7'-8"		
200	LOFT	WD	CPT	CPT-	WD	PT-	4"	GWB	8'-4 ½"	PT-	PT-	PT-	PT-	GWB	PT-		8'-4 ½"		
201	SEWING ROOM	WD	CPT	CPT-	WD	PT-	4"	GWB	8'-4 ½"	PT-	PT-	PT-	PT-	GWB	PT-		8'-4 ½"		
202	ATTIC	WD	UNF					GWB	9'-6"					GWB	PT-		9'-6"		

GYP BOARD KEY: GWB = ½" GWB-2 = ½" WATER RESIST. GWB-3 = %" TYPE 'X' FIRE RATED


FLOOR FINISH KEY: CONC = CONCRETE CK = CORK CPT = CARPET CT = CERAMIC TILE

MATERIAL/FINISH KEY: WD = WOOD PT = PAINT ST = STAINED

DOOR SCHEDULE

			DOOR															
DOOR	ROOM	QTY.	WIDTH	HEIGHT	DEPTH	TYPE	RATING	MATERIAL	FINISH	TYPE	DEPTH	RATING	FINISH	MATERIAL GLASS	DETAILS	THRESHOLD	HARDWARE	NOTES*
G01	GARAGE	1	3'-0"	7'-0"	1 3/4"	F		MET	Р	F1	4 1/2"		P	WD		ALUM		INSULATED
G02	WORKSHOP	1	3'-0"	6"-8"	1 3/8"	F		SC WD	Р	F1	4 1/2"		P	WD		ALUM		FF STAINED
G03	GARAGE	2	9'-0"	7'-0"	1 3/4"	F		MET	Р	F1	4 1/2"		Р	WD				INSULATED
G04	WORKSHOP	1	3'-0"	7'-0"	1 3/4"	HG		MET	Р	F1	4 1/2"		Р	WD I TEMP		ALUM		INSULATED
B01	BASEMENT	1	2'-8"	6"-8"	1 3/8"	F		WD	Р	F1	3 1/2"		P	WD				FF STAINED
100	AIR LOCK	1	3'-0"	7'-0"	1 3/4"	FG		SC WD	Р	F1	6"		TBD	WD I-2		ALUM		FF STAINED
101	FOYER	1	3'-0"	7'-0"	1 3/4"	F		SC WD	Р	F1	6"		P	WD				FF STAINED
102	CLOSET	1	2'-8"	6"-8"	1 3/8"	F		SC WD	Р	F1	5 1/2"		P	WD				FF STAINED
103	BATHROOM #1	1	2'-8"	6"-8"	1 3/8"	F		SC WD	Р	F1	5 1/2"			WD				FF STAINED
104	BEDROOM #2	1	2'-8"	6"-8"	1 3/8"	F		SC WD	Р	F1	5 1/2"		P	WD				FF STAINED
105	MASTER BEDROOM	1	2'-8"	6"-8"	1 3/8"	F		SC WD	Р	F1	5 1/2"		P	WD				FF STAINED
106	CLOSET DOORWAY								Р	F1	5 1/2"			WD				6' DOORWAY
107	KITCHEN/PATIO	1	3'-0"	7'-0"	1 3/4"	FG		SC WD*	Р	F1	6"		P	WD I-2		ALUM		INTR. FF STAINED EXT. ALUM CLAD
108	LIVING/DINING	1	3'-0"	7'-0"	1 3/4"	FG		SC WD	Р	F1	6 1/4"		P	WD I-2		ALUM		INTR. FF STAINED EXT. ALUM CLAD
109	BEDROOM #3	1	2'-8"	6"-8"	1 3/8"	F		SC WD	Р	F1	4 1/2"		P	WD				FF STAINED
110	CLOSET	1	2'-8"	6"-8"	1 3/8"	F		SC WD	Р	F1	4 1/2"		P	WD				FF STAINED
111	BEDROOM #4	1	2'-8"	6"-8"	1 3/8"	F		SC WD	Р	F1	4 1/2"		P	WD				FF STAINED
112	CLOSET	1	2'-8"	6"-8"	1 3/8"	F		SC WD	Р	F1	4 1/2"		P	WD				FF STAINED
113	LAUNDRY	1	2'-8"	6"-8"	1 3/8"	F		SC WD	Р	F1	6"		P	WD				FF STAINED
114	BATHROOM #2	1	2'-6"	6"-8"	1 3/8"	F		SC WD	Р	F1	5 1/2"		P	WD				FF STAINED
115	BATHROOM #2	1	2'-8"	6"-8"	1 3/8"	F		SC WD	Р	F1	5 1/2"		P	WD				FF STAINED
116	PATIO	2	3'-0"	7'-0"	1 3/4"	SCR		WD	Р	F1	5 1/2"			WD				FF STAINED
201	SEWING ROOM	1	2'-8"	6'-8"	1 3/8"	F		SC WD*	Р	F1	4 1/2"		P	WD				FF STAINED
202	ATTIC	1	2'-8"	6'-8"	1 3/8"	F		SC WD	Р	F1	4 1/2"		P	WD				FF STAINED

NOTE:

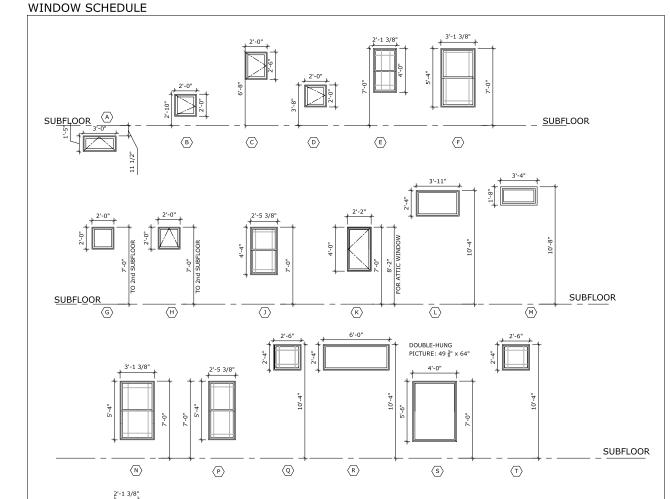

- WINDOWS BASED ON JELD-WEN.PROVIDE CLAD EXTERIOR, EXTENSION JAMBS & SCREENS,

- ALL DIMENSIONS ARE FRAME SIZE. COORDINATE WITH MANUFACTURER'S ROUGH OPENING SIZES.
- INTERIOR FINISH PER OWNER, PER ROOM.

UNLESS OTHERWISE NOTED.

U

GARAGE


<u>T.O. SLAB</u> HIGH POINT

n •site: architectur CONSULTANTS: STAMP PROJECT NAME HALFMAN RESIDENCE LOT 48 BENTON, N.Y. PROJECT NUMBER: 0640 DATE: 08.20.07 DRAWN BY: KE, LS, JV CHECKED BY: RH SHEET TITLE

SCHEDULES

SHEET NUMBER


A-10

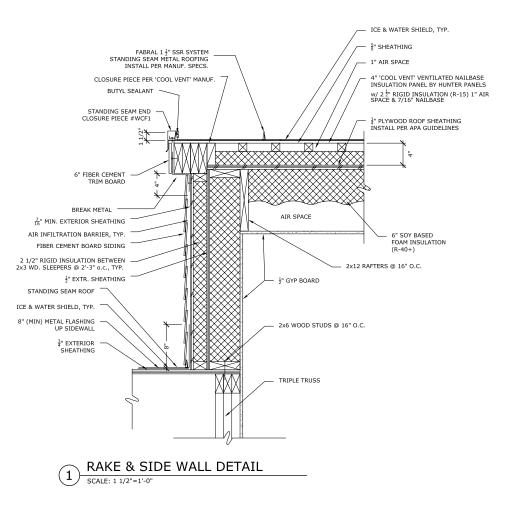


 $5\frac{1}{2}$ " SPRAY FOAM INSULATION, TYP. 1" GYP BOARD, TYP. ₹ MIN. EXTERIOR SHEATHING AIR INFILTRATION BARRIER, TYP 2x6 STUDS J.M. FIBER CEMENT SIDING TRIM BOARDS FOUNDATION

PORCH PLAN DETAIL


WINDOW JAMB DETAIL SCALE: 1 1/2"=1'-0"

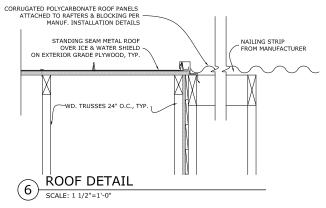

INSIDE

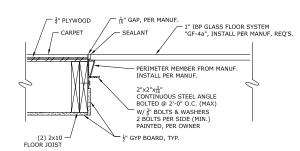

GLASS FLOOR DETAIL OPTION 1

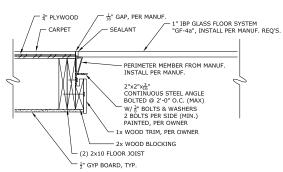

GLASS FLOOR DETAIL OPTION 2

WOOD CASING, PER OWNER 2x6 WOOD STUDS @ 16" O.C., TYP. LOW PRESSURE FOAM BY OTHERS WOOD TRIM PIECE 1" GYP BOARD, TY - wood sill SOY BASED INSULATION JELD-WEN WINDOW BUILDER SERIES SHIM AS REO'D SEALANT & BACKER ROD l_{½"} PLYWOOD -2 ½" RIGID INSULATION ₹" OSB FIBER CEMENT SIDING 4" FIBER CEMENT TRIM 2x3 BLOCKING

STAMP

n •site: architectur

CONSULTANTS:

PROJECT NAME

HALFMAN RESIDENCE

> LOT 48 BENTON, N.Y.

PROJECT NUMBER: 0640


DATE: 08.20.07 DRAWN BY: KE, LS, JV

CHECKED BY: RH SHEET TITLE

DETAILS

SHEET NUMBER

A-11

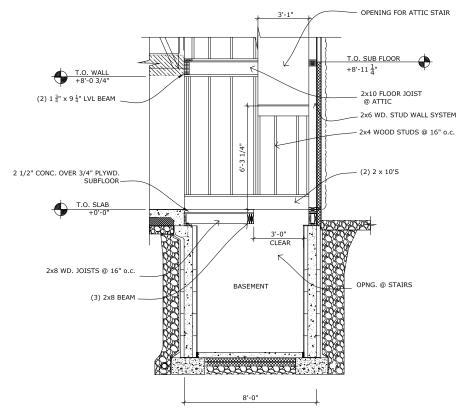

NOT USED

BASEMENT STAIR DETAIL

SCALE:3/8"=1'-0"

